



STROPODACH – ZBROJENIE DOLNE I GÓRNE

SKALA 1:100
PŁYTA STROPOWA gr.18cm

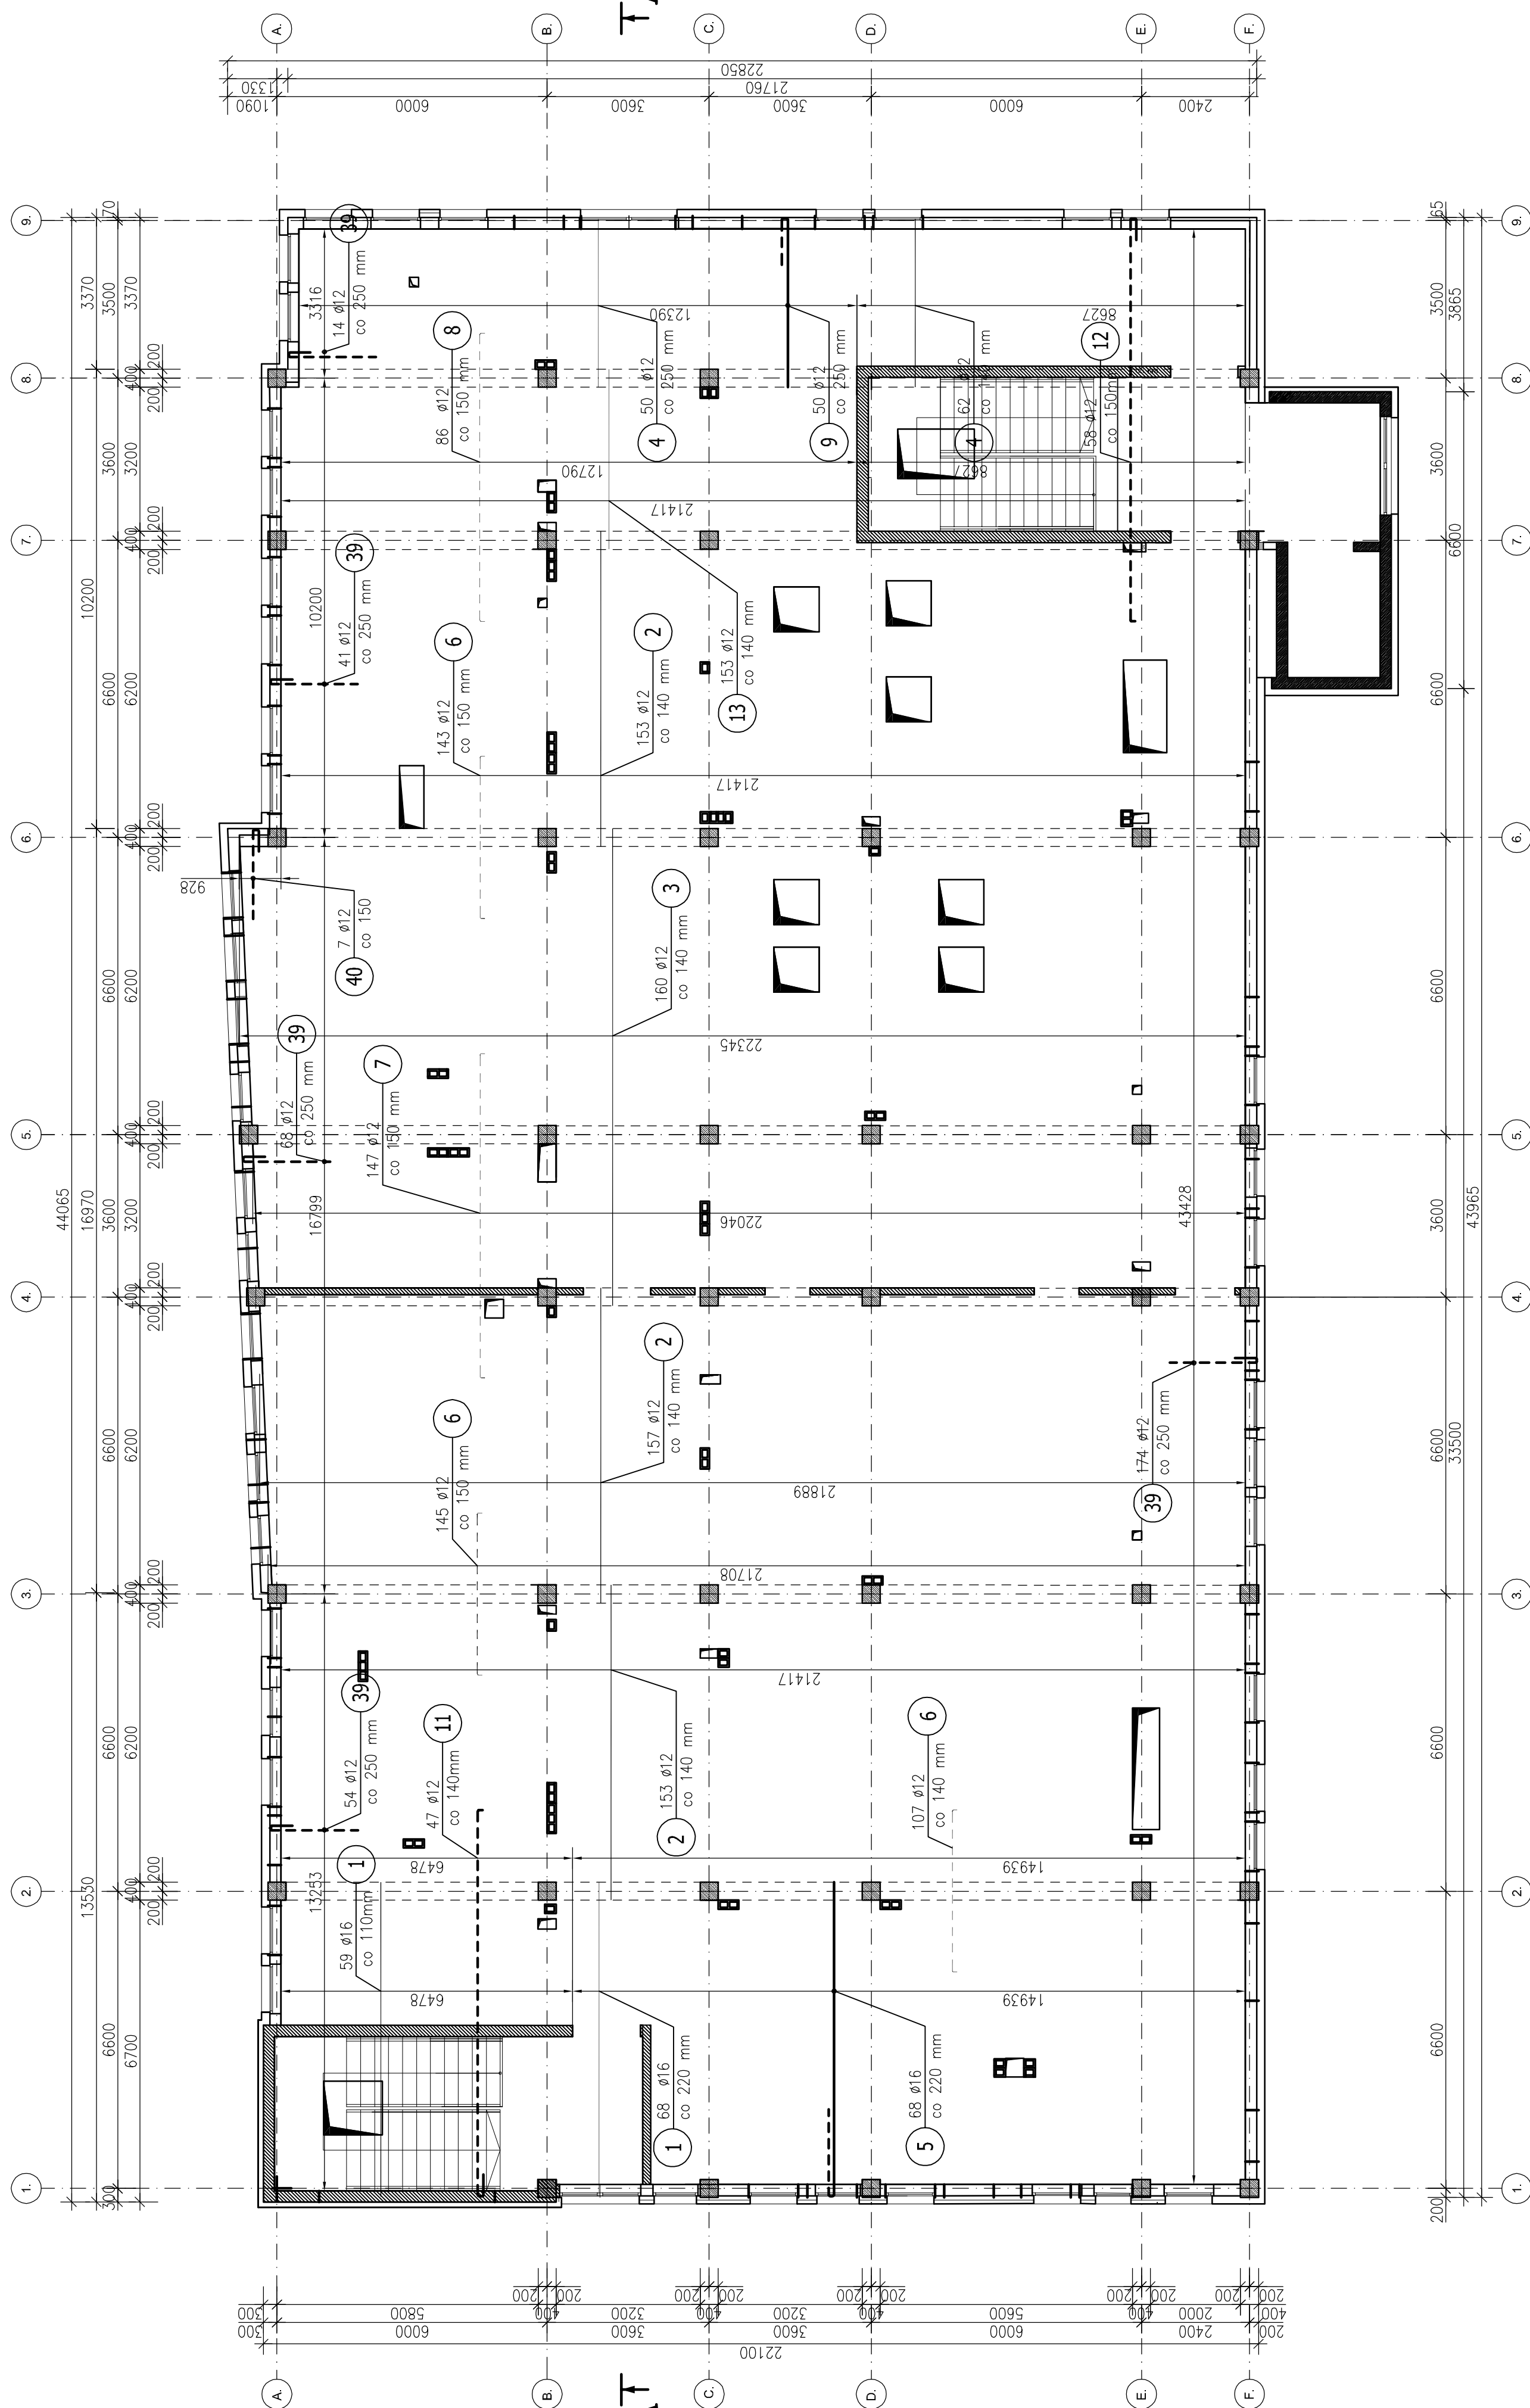


STROPODACH – OTWOROWANIE

SKALA 1:100
PŁYTA STROPOWA gr.18cm

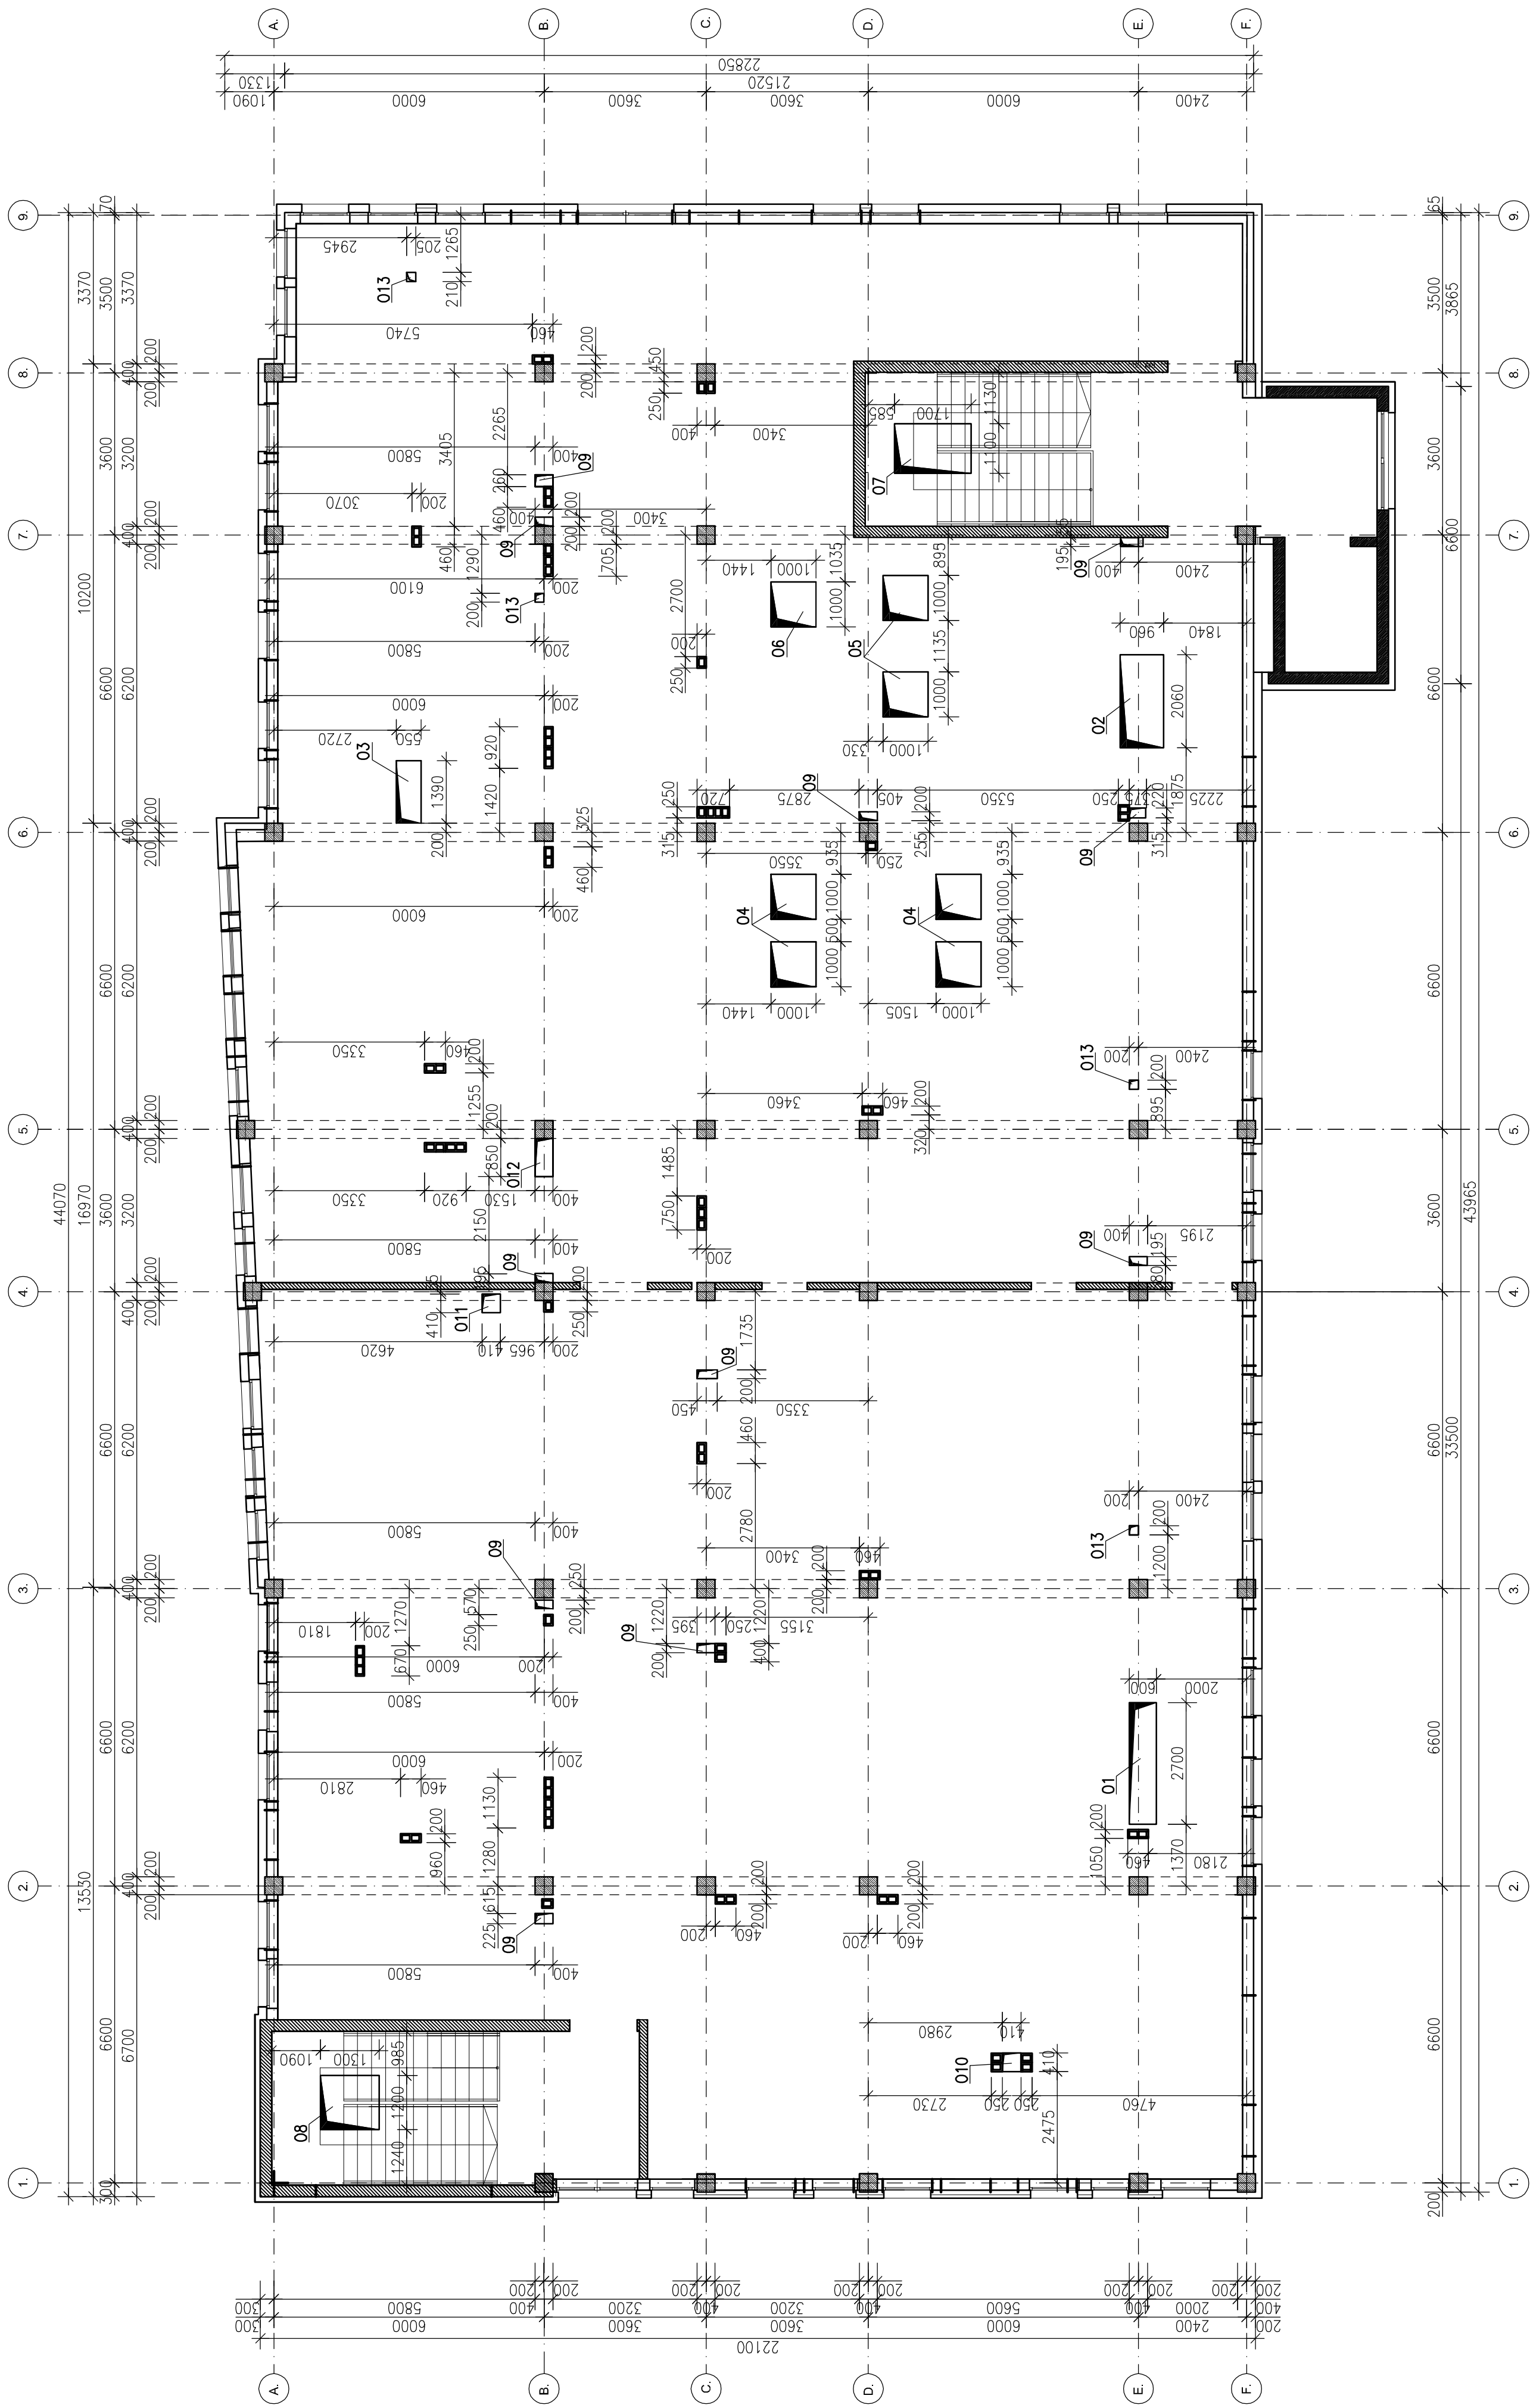

A – A
STROPODACH W POZIOME +10.96

SKALA 1:20

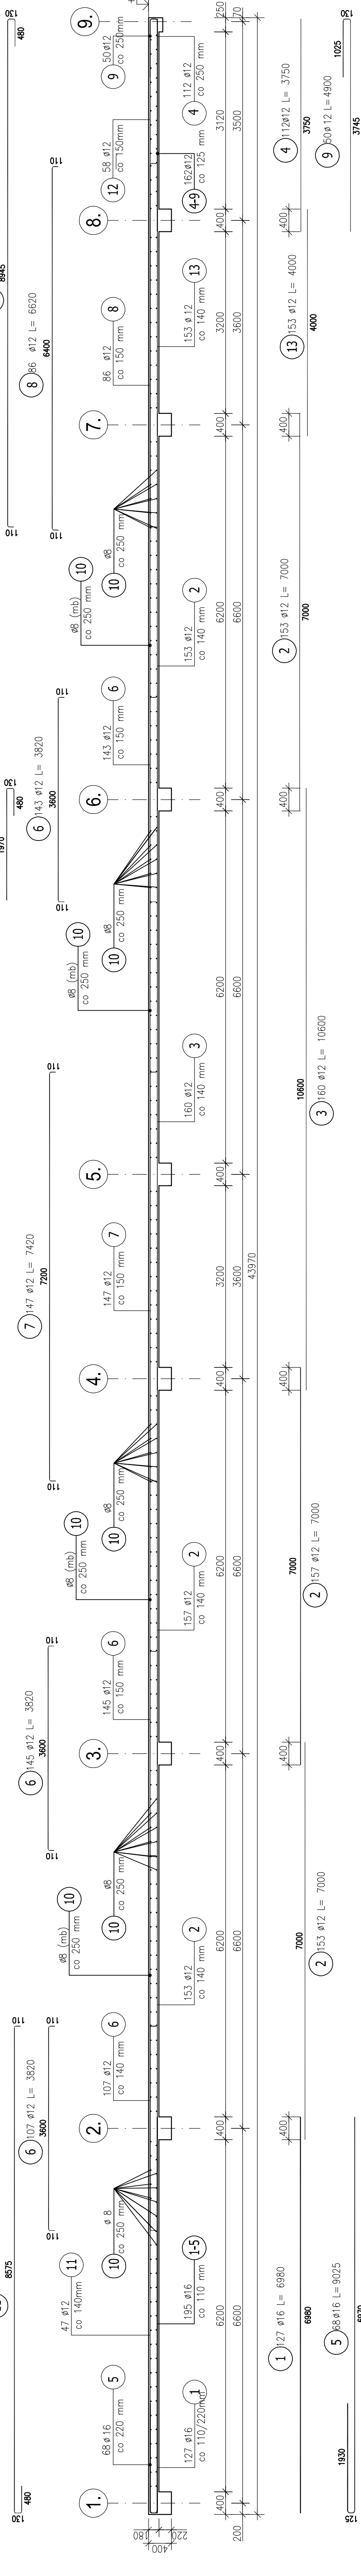

ZESTAWIENIE STALI ZBROJENIOWEJ									
NR POZ.	PRZEM. [mm]	DLUGOŚĆ [m]	PRZEM. x POZ. RAZEM	ŁŁCZ. RAZEM	NR POZ.	PRZEM. [mm]	DLUGOŚĆ [m]	PRZEM. x POZ. RAZEM	ŁŁCZ. RAZEM
Pos. 1 – STROPODACH W POZIOME +10.96 – 1 szel									
1	16	6.980	127	1	127	2	12	7.000	153
2	12	7.000	157	1	157	3	12	7.000	153
3	12	7.000	153	1	153	4	12	10.600	160
4	12	3.750	112	1	112	5	16	9.025	68
5	16	9.025	68	1	68	6	12	3.820	143
6	12	3.820	143	1	143	7	12	3.820	107
7	12	7.420	147	1	147	8	12	7.420	147
8	12	6.620	66	1	66	9	12	6.620	66
9	12	9.144	000	1	9.144	10	8	9.144	000
10	8	9.144	000	1	1	11	12	9.295	47
11	12	9.295	47	1	47	12	12	9.665	35
12	12	9.665	35	1	35	13	12	1.030	413
13	12	1.030	413	1	153	14	8	1.030	513
14	8	1.030	513	1	513	15	12	4.320	8
15	12	4.320	8	1	8	16	12	3.000	8
16	12	3.000	8	1	8	17	12	3.000	8
17	12	1.000	464	1	464	18	12	2.700	8
18	12	2.700	8	1	8	19	12	2.700	8
19	12	2.700	8	1	8	20	12	2.700	8
20	12	2.700	8	1	8	21	16	5.100	16
21	16	5.100	16	1	16	22	12	2.500	16
22	12	2.500	16	1	16	23	16	6.000	8
23	16	6.000	8	1	8	24	16	6.000	8
24	16	6.000	8	1	8	25	12	3.300	4
25	12	3.300	4	1	4	26	16	3.900	16
26	16	3.900	16	1	16	27	12	3.900	12
27	12	3.900	12	1	12	28	12	3.900	12
28	12	3.900	12	1	12	29	12	1.500	44
29	12	1.500	44	1	44	30	12	1.500	89
30	12	1.500	89	1	89	31	12	1.500	4
31	12	1.500	4	1	4	32	16	1.500	4
32	16	1.500	4	1	4	33	12	1.600	8
33	12	1.600	8	1	8	34	16	2.200	8
34	16	2.200	8	1	8	35	12	2.200	8
35	12	2.200	8	1	8	36	12	2.100	8
36	12	2.100	8	1	8	37	12	1.900	16
37	12	1.900	16	1	16	38	12	1.900	16
38	12	1.900	16	1	16	39	12	1.700	208
39	12	1.700	208	1	208	40	8	3.770	14
40	8	3.770	14	1	14	41	12	2.315	351
41	12	2.315	351	1	351	42	12	0.900	2
42	12	0.900	2	1	2	43	12	0.900	2
43	12	0.900	2	1	2	44	12	0.900	2
44	12	0.900	2	1	2	45	12	1.750	64
45	12	1.750	64	1	64	46	12	1.750	64
46	12	1.750	64	1	64	47	12	1.750	64
47	12	1.750	64	1	64	48	12	1.750	64
153	12	1.750	64	1	64	154	12	1.750	64
154									